


73m of 2.4m Palisade fencing to replace existing timber fence and infill gaps within hedge

60m of 2.4m Palisade fencing to replace existing timber fence and infill gaps within hedge

apparent possibility of diverted Henhull FP3 path currently under consideration by Cheshire East Council

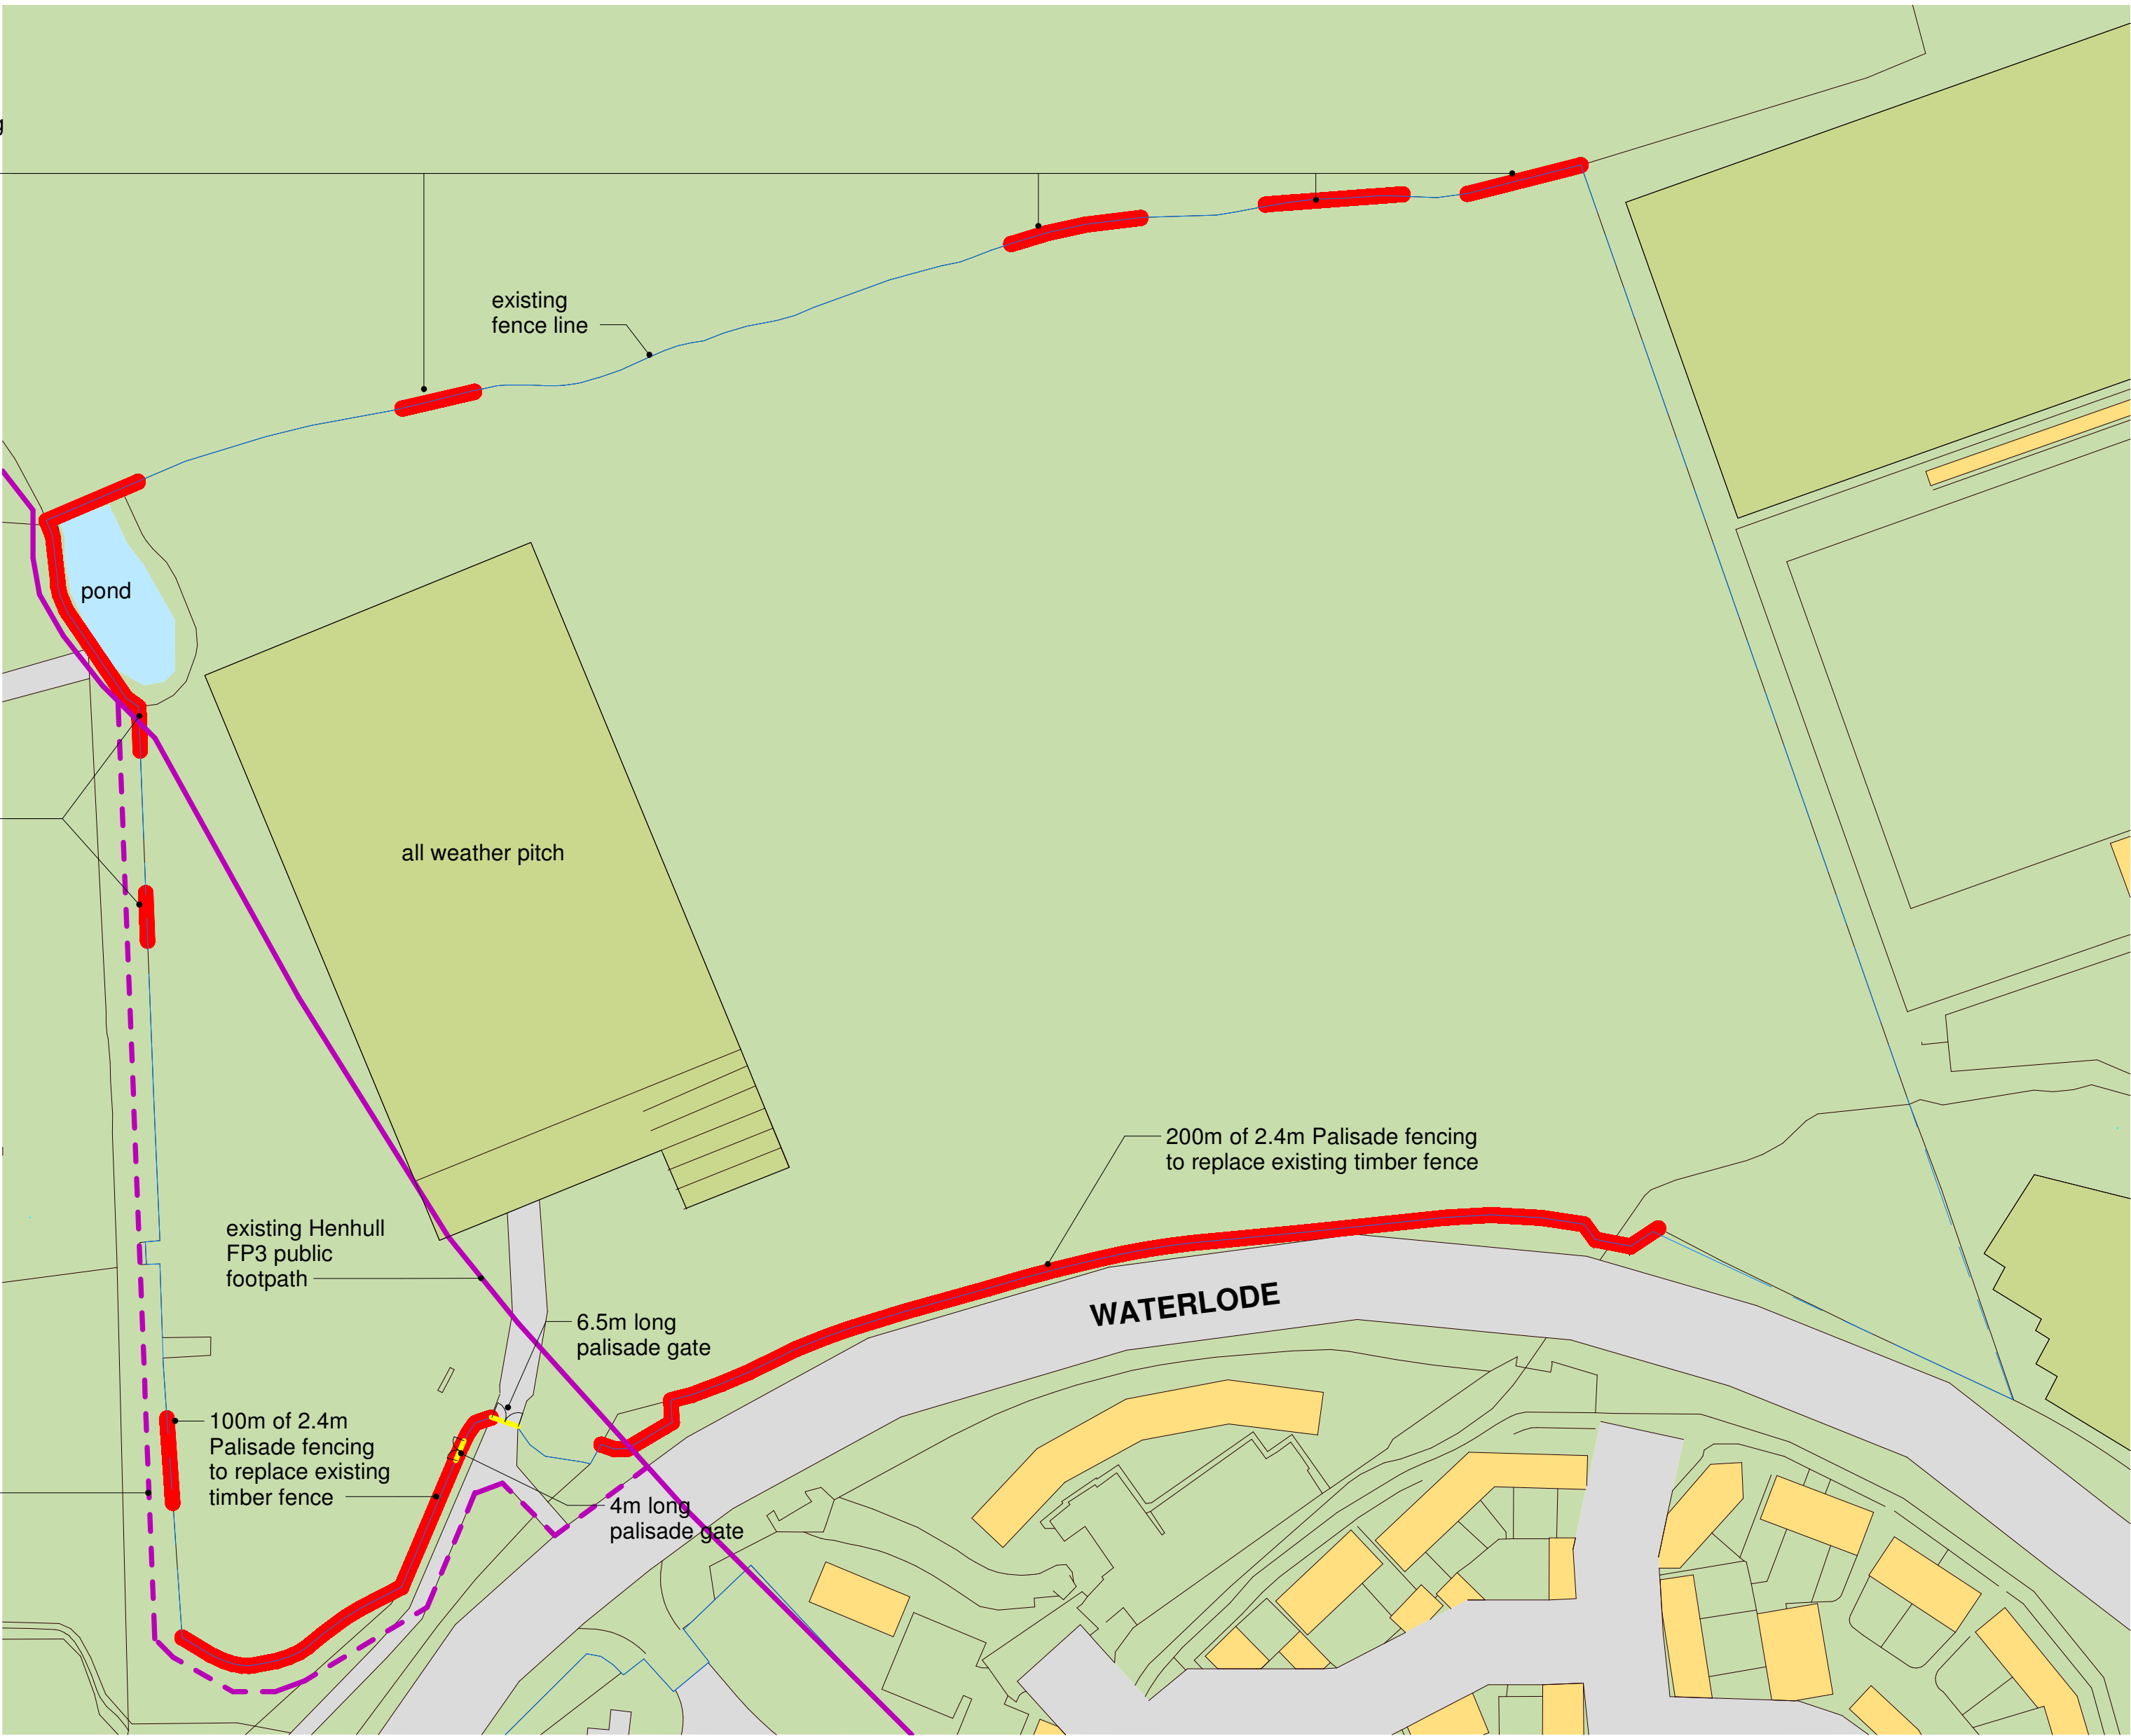

1 Proposed site plan

Scale: 1 : 1000

Proposed Boundary Treatments

- Proposed New palisade fencing 2400mm_green
- Proposed New palisade gate, 2400mm_green
- Line of existing 3 rail timber fence


Legend_Boundary Treatments



sample image, green powder coated palisade railing, 2.4m




sample image, green powder coated palisade gate, 2.4m

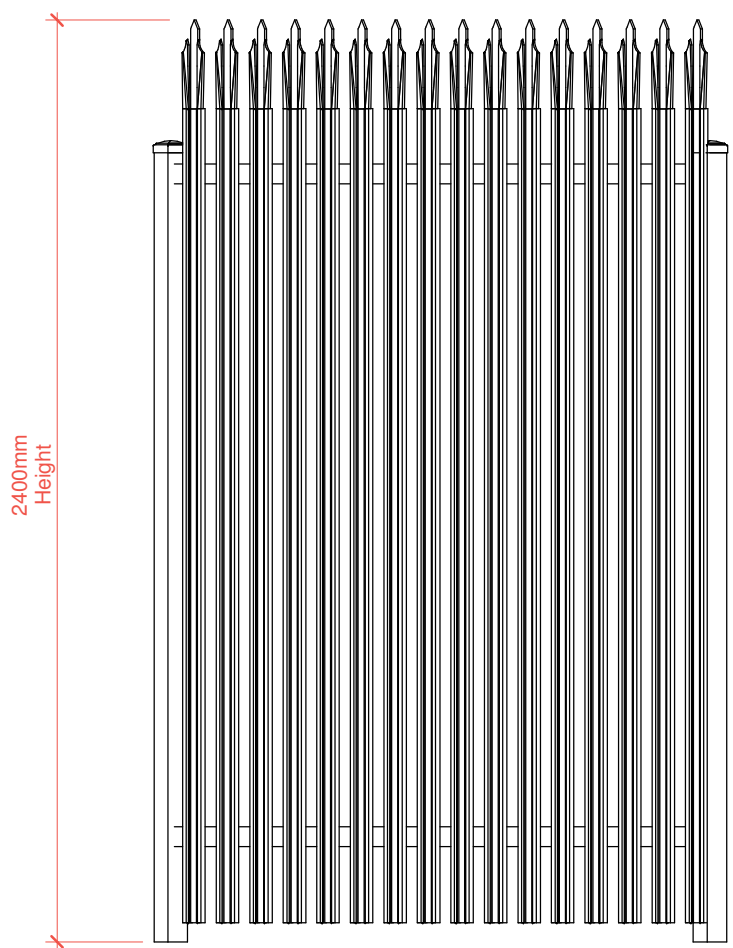

2 D section palisade, green powder coated fencing

Scale: 1 : 20

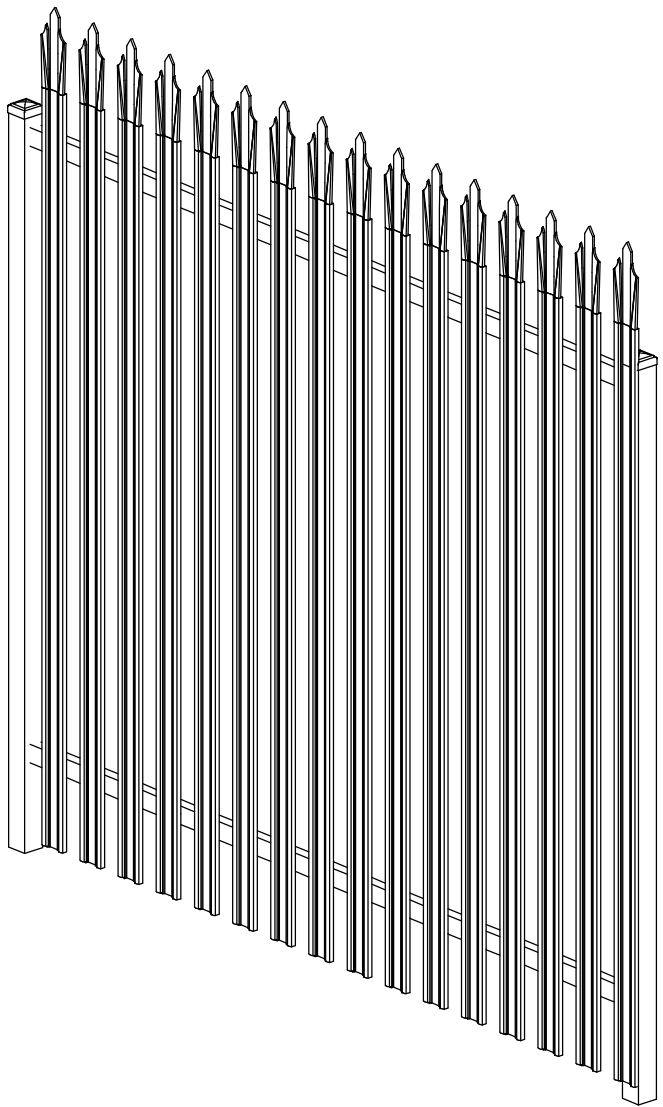

3 3D Ortho_palisade fencing

Scale:

0m 20m 40m 60m 80m A1

VISUAL SCALE 1:1000 @ A1

This drawing must be printed in colour to be read correctly

Notes

Figured dimensions are to be used in all cases. Dimensions should not be scaled from drawing. All existing dimensions should be checked on site before commencement of the work. Any discrepancies in dimensions should be clarified with the Architect prior to commencement of the work. No deviation from this drawing will be permitted without the prior written consent of the Architect. This drawing is to be read in conjunction with all the relevant Mechanical and Electrical drawings. This drawing is to be read in conjunction with the relevant Structural Engineer's drawings, structural calculations and recommendations. This drawing is to be read in conjunction with the relevant Fire Safety Strategy drawings.

This drawing must be read in conjunction with LMA drawing 7500_Strategy_DesignersRiskAssessment which indicates all current and active designers risks that have been identified by Lovelock Mitchell Architects in accordance with the CDM Regulations 2015.

This drawing is copyright and to be returned to the architect on completion of the contract.

P1	Issued for Planning Approval	SA	CR	25.08.21
Rev.	Revision description	Drawn	Checked	Date



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Project
Malbank School_Fencing
Malbank school and sixth form

Title
External works_proposed

LMA Project	Drawing number	Rev.
0000	XXX LMA XX XX DR A 7503	P1